

OWNER

STUDIO VOLCY

412.229.7040 https://www.studiovolcy.com

PROJECT TEAM


PROJECT ARCHITECT GBBN Architects Inc.

5411 Penn Ave Pittsburgh, PA 15206 T 513.241.8700 www.gbbn.com

STRUCTURAL WBCM

600 Bursca Dr #609 Bridgeville, PA 15017 T 412. 221.5385

LOCATION MAP

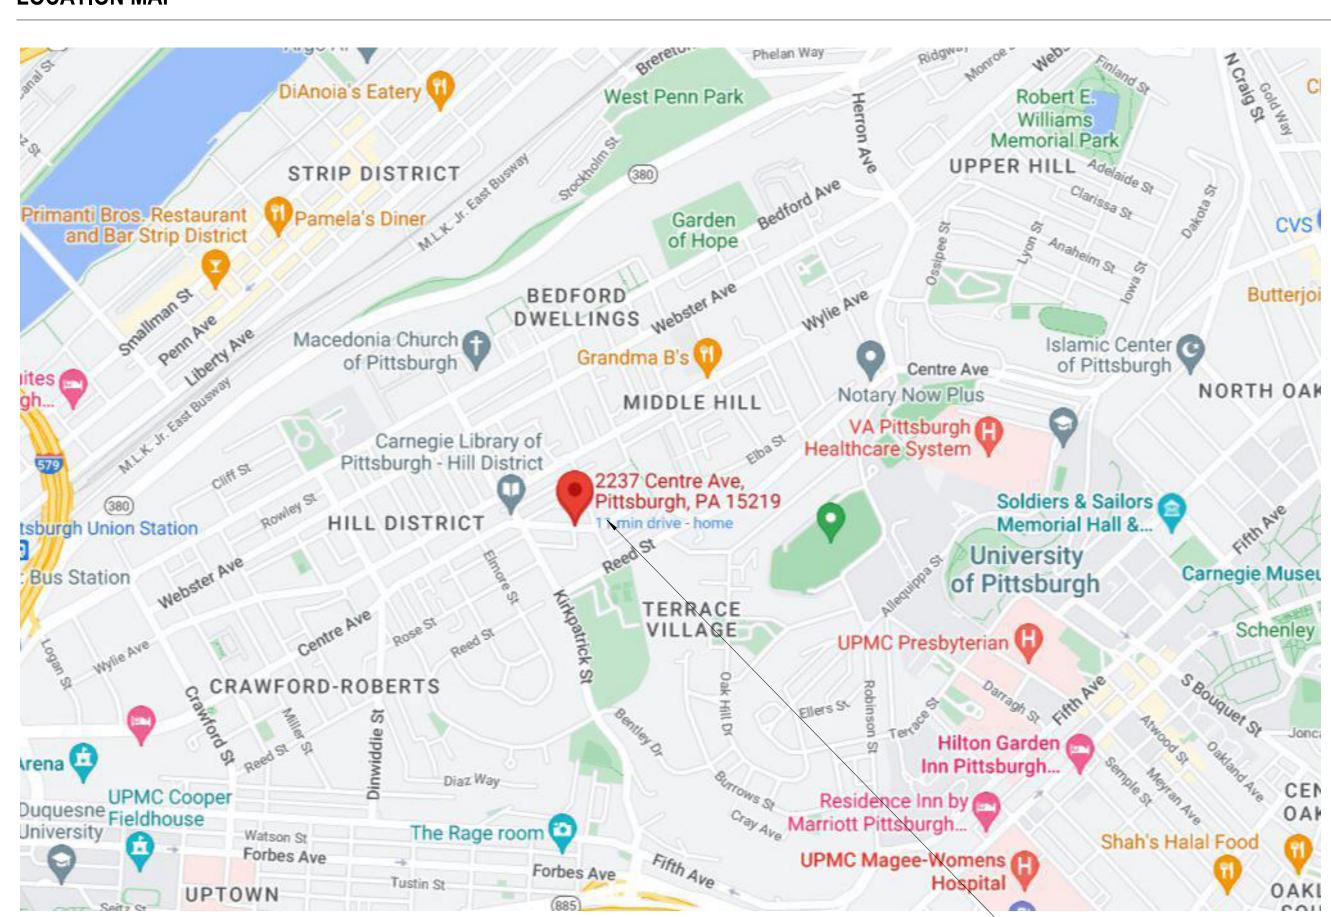

RHYTHM SQUARE

2237 Centre Ave, Pittsburgh, PA 15219

DRAWING INDEX

| SHEET NUMBER GENERAL | SHEET NAME | Issued for_G |
|-------------------------------|------------|--------------|
| G001 TITLE SHEET | | • |
| LIFE SAFETY PLANS & CODE | SUMMARY | • |
| RCHITECTURAL ORIENTATION | | |
| A001 ARCHITECTURAL SITE PLAN | | • |
| RCHITECTURAL DEMO | | |
| D101 LEVEL 1 DEMOLITION PLAN | | • |
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| 101 FLOOR PLANS | | • |
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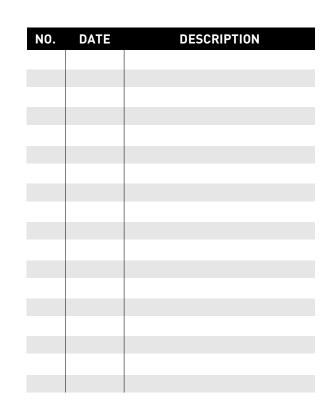


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DRAWING ISSUE

SCHEMATIC DESIGN



DRAWING TITLE


TITLE SHEET

C

JOB NUMBER

14754

G001 12.19.22

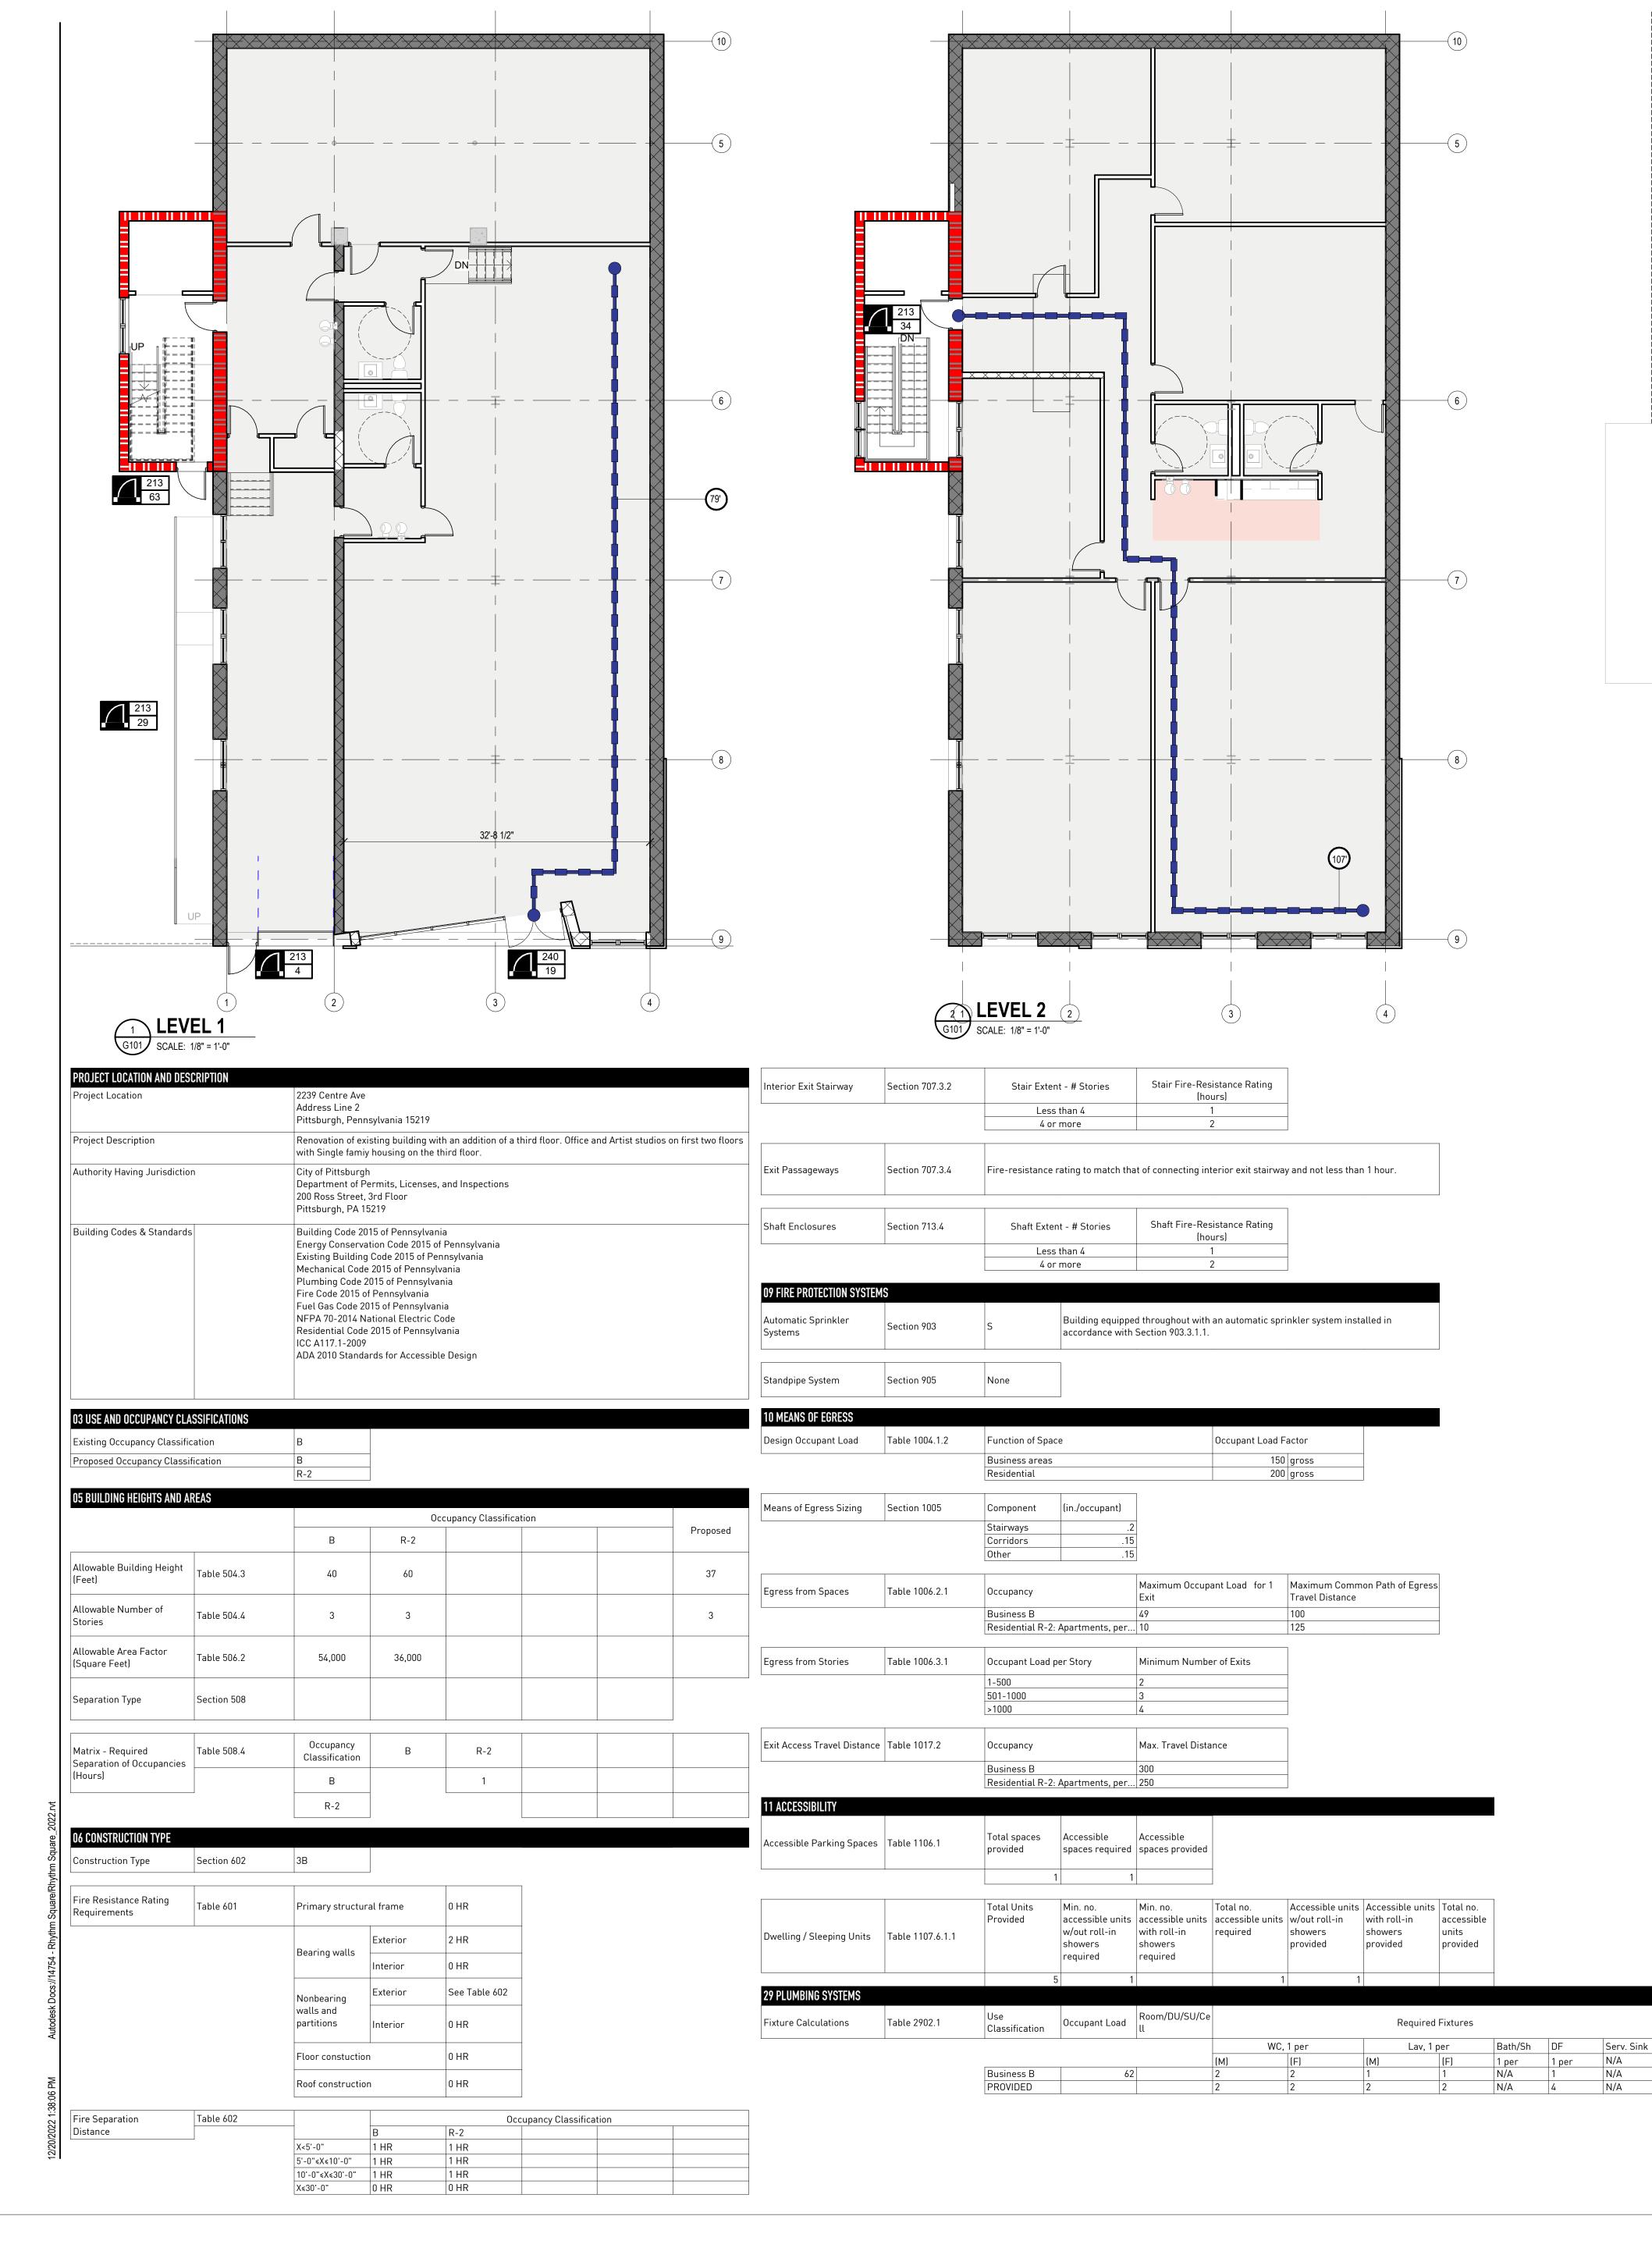



GENERAL NOTES - LIFE SAFETY PLAN

A. TRAVEL DISTANCES SHOWN ARE THE MOST EXTREME CONDITIONS.

B. DOOR OCCUPANT CAPACITY SHOWN IS THE CLEAR OPENING IN THE OPEN POSITION - NOT THE SCHEDULED DOOR WIDTH.

C. EXCEPT WHERE SPECIFICALLY PERMITTED BY THE BUILDING CODE AND INDICATED IN THE DOOR SCHEDULE, DOORS IN THE MEANS OF EGRESS - INCLUDING ELECTRONIC ACCESS CONTROL DOORS - SHALL BE READILY OPENABLE FROM THE EGRESS SIDE WITHOUT THE USE OF A KEY OR SPECIAL KNOWLEDGE OR EFFORT.

PARTITION AND WALL GRAPHIC KEY

NON-RATED PARTITION NON-RATED PARTITION (EXISTING) 1 HOUR FIRE BARRIER 1 HOUR FIRE BARRIER (EXISTING) 2 HOUR FIRE BARRIER 2 HOUR FIRE BARRIER (EXISTING) 3 HOUR FIRE BARRIER 3 HOUR FIRE BARRIER (EXISTING) 1 HOUR FIRE AND SMOKE BARRIER 1 HOUR FIRE AND SMOKE BARRIER (EXISTING) 2 HOUR FIRE AND SMOKE BARRIER 2 HOUR FIRE AND SMOKE BARRIER (EXISTING) SMOKE RESISTING PARTITION SMOKE RESISTING PARTITION (EXISTING) 1 HOUR SMOKE BARRIER

LIFE SAFETY SYMBOL KEY

DOOR ACTUAL OCCUPANTS

180 DOOR OCCUPANT CAPACITY 120 RAMP ACTUAL OCCUPANTS

1 HOUR SMOKE BARRIER (EXISTING)

2 HOUR SMOKE BARRIER (EXISTING)

2 HOUR SMOKE BARRIER

120 T STAIR ACTUAL OCCUPANTS STAIR OCCUPANT CAPACITY - ILLUMINATED SURFACE EXIT SIGN

DIRECTION OF ARROW

RAMP OCCUPANT CAPACITY

DISTANCE OF COMMON PATH OF TRAVEL DISTANCE OF PATH OF TRAVEL AND COMMON PATH OF TRAVEL COMBINED

DISTANCE OF DEAD END CORRIDOR TRAVEL

FIRE EXTINGUISHER

FIRE DEPARTMENT CONNECTION FIRE HOSE CONNECTION COMMON PATH OF TRAVEL FROM MOST REMOTE LOCATION TO DECISION - - - •

TOTAL TRAVEL DISTANCE FROM EITHER MOST REMOTE LOCATION •---> OR DECISION POINT TO EXIT • - - -> DEAD END COORIDOR TRAVEL DISTANCE FROM

FIRE PULL

AUTOMATED EXTERNAL DEFIBRILLATOR

FIRE HYDRANT

AREA OCCUPANCY CLASSIFICATION

ASSEMBLY WITHOUT FIXED SEATS: UNCONCENTRATED (TABLES AND CHAIRS)

BUSINESS AREAS

RESIDENTIAL

| | | | | | CODE - OCCUPANT LOA | <u></u> | T | | 100G Code Cooun | Occupancy Load |
|------------|-------------|-------------------------|---------|---|---------------------|---------------------|-------------|---------------------|-----------------|----------------|
| Level | Name | Area Type | Area | Occupancy | OccupancySFType | OccupancyTypeActual | SFPerPerson | Area Occupancy Calc | antLoad | Check |
| _evel 1 | STUDIO | Building Common Area | 2830 SF | BUSINESS AREAS | gross | No | 150 | 18.9 | | |
| _evel 1 | STUDIO | Building Common Area | 601 SF | BUSINESS AREAS | gross | No | 150 | 4.0 | | |
| _evel 1 | STUDIO | Building Common Area | 251 SF | BUSINESS AREAS | gross | No | 150 | 1.7 | | |
| _evel 1 | STUDIO | Building Common Area | 573 SF | BUSINESS AREAS | gross | No | 150 | 3.8 | | |
| Level 1: 4 | | | | | | I | 28.4 | | L | |
| _evel 2 | STUDIO | Building Common Area | 461 SF | BUSINESS AREAS | gross | No | 150 | 3.1 | | |
| _evel 2 | STUDIO | Building Common Area | 468 SF | BUSINESS AREAS | gross | No | 150 | 3.1 | | |
| _evel 2 | STUDIO | Building Common Area | 326 SF | BUSINESS AREAS | gross | No | 150 | 2.2 | | |
| _evel 2 | STUDIO | Building Common Area | 765 SF | BUSINESS AREAS | gross | No | 150 | 5.1 | | |
| _evel 2 | STUDIO | Building Common Area | 935 SF | BUSINESS AREAS | gross | No | 150 | 6.2 | | |
| _evel 2 | TLT | Building Common Area | 712 SF | BUSINESS AREAS | gross | No | 150 | 4.7 | | |
| _evel 2 | KITCHENETTE | Building Common Area | 92 SF | ASSEMBLY WITHOUT FIXED SEATS: UNCONCENTRATED (TABLES AND CHAIRS) | net | No | 15 | 6.1 | | |
| _evel 2 | | Building Common Area | 472 SF | BUSINESS AREAS | gross | No | 150 | 3.1 | | |
| _evel 2: 8 | | | | | | | I | 33.7 | | |
| EVEL 3 | UNIT | Building Common Area | 3990 SF | RESIDENTIAL | gross | No | 200 | 20.0 | | |
| EVEL 3: 1 | 1 | I. | 1 | 1 | 1 | 1 | 1 | 20.0 | 1 | L |

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DRAWING ISSUE

SCHEMATIC DESIGN

NO. DATE DESCRIPTION

DRAWING TITLE

LIFE SAFETY PLANS & CODE SUMMARY

JOB NUMBER

14754

12.19.22

GENERAL NOTES: DEMOLITION FLOOR PLAN

REQUIREMENTS DESCRIBED THEREIN.

CASEWORK, MILLWORK, AND TRIM.

 REFER TO THE PROJECT MANUAL FOR GENERAL DEMOLITION PROCEDURES, SALVAGING, PROTECTION, COORDINATION WITH NEW WORK, TRAFFIC AND CIRCULATION, UTILITIES, ACCESS AND TEMPORARY CONTROLS/FACILITIES, POLLUTION CONTROLS, SHORING, CUTTING AND PATCHING, LIFE SAFETY PROCEDURES, AND OTHER DEMOLITION

COORDINATE DEMOLITION INFORMATION SHOWN ON THIS PLAN WITH OTHER DEMOLITION

WHERE INTERIOR SPACES ARE SHOWN WITH DASHED LINES AND EXCEPT AS INDICATED

FINISHED CEILINGS, CEILING SUSPENSION SYSTEMS, CEILING MOUNTED DEVICES,

REFER TO MECHANICAL, ELECTRICAL, PLUMBING AND FIRE PROTECTION DRAWINGS FOR

WHERE MEP/FP DRAWINGS SHOW EQUIPMENT, DUCTS OR PIPES TO BE REMOVED

STRUCTURAL DRAWINGS FOR FRAMING AND ANY ADDITIONAL REQUIREMENTS.

COORDINATE WITH MECHANICAL, ELECTRICAL, PLUMBING AND FIRE PROTECTION

IN THE EVENT A CONTRACTOR ENCOUNTERS, ON THE SITE, MATERIAL REASONABLY

NON-LOAD BEARING PARTITIONS, WALL-MOUNTED ITEMS, DOORS AND FRAMES, FLOORING,

ADDITIONAL DEMOLITION REQUIREMENTS. DISCONNECT AND CAP UTILITIES AS INDICATED

RESULTING IN UNPROTECTED OPENINGS IN THE FLOOR OR ROOF, AND THESE OPENINGS ARE NOT SHOWN TO BE RE-USED IN THE NEW CONSTRUCTION, PATCH/INFILL THE EXISTING FLOOR AND ROOF PENETRATIONS TO MATCH THE EXISTING CONSTRUCTION. REFER TO THE

UNLESS INDICATED OTHERWISE, REMOVE AND DISPOSE OF WALL-MOUNTED AND COLUMN-

BELIEVED TO BE ASBESTOS OR POLYCHLORINATED BIPHENYL (PCB) WHICH HAS NOT BEEN RENDERED HARMLESS, THE CONTRACTOR SHALL IMMEDIATELY STOP WORK IN THE AREA AFFECTED AND REPORT THE CONDITION TO THE OWNER, ARCHITECT, AND CONSTRUCTION MANAGER IN WRITING. REFER ALSO TO THE GENERAL CONDITIONS OF THE CONTRACT.

> REMOVE DOOR. REFER TO DOOR SCHEDULE FOR INSTANCES OF REUSING THE FRAME AND/OR SALVAGING HARDWARE.

NEW FLOOR OPENING OR SLAB TO BE REMOVED. COORDINATE LOCATION WITH NEW WORK DRAWINGS. FOR FLOOR OPENINGS, COORDINATE REQUIREMENTS WITH STRUCTURAL DRAWINGS AND FIELD

TRADES AND WITH NEW WORK INDICATED ON OTHER DRAWINGS.

OTHERWISE, REMOVE AND DISPOSE OF THE FOLLOWING:

D. MECHANICAL, ELECTRICAL, PLUMBING, FIRE PROTECTION DEMOLITION

MOUNTED ITEMS WHERE WALLS AND COLUMNS ARE TO REMAIN.

— — — — — — REMOVE WALL / PARTITION FULL — — — — — HEIGHT TO STRUCTURE

WALL / PARTITION TO REMAIN

DOOR TO REMAIN

THE INTENT OF THIS PLAN IS TO DESCRIBE GENERAL AREAS OF DEMOLITION.

A. DEMOLITION PROCEDURES

C. ARCHITECTURAL DEMOLITION

E. WALL MOUNTED ITEMS

F. HAZARDOUS MATERIALS

DEMOLITION GRAPHIC KEY

| ======

HEX (D) DEMOLITION PLAN NOTES

KEYNOTE DESCRIPTION

B. **COORDINATION**

DEMOLISH INTERIOR FINISHES AND WOOD FRAMES

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SCHEMATIC DESIGN



DRAWING TITLE

LEVEL 1 DEMOLITION PLAN



JOB NUMBER

14754






LEVEL 1


DEMOLISH INTERIOR NON STRUCTURAL WALLLS, FINISHES, LIGHTS AND


BULK HEADS.






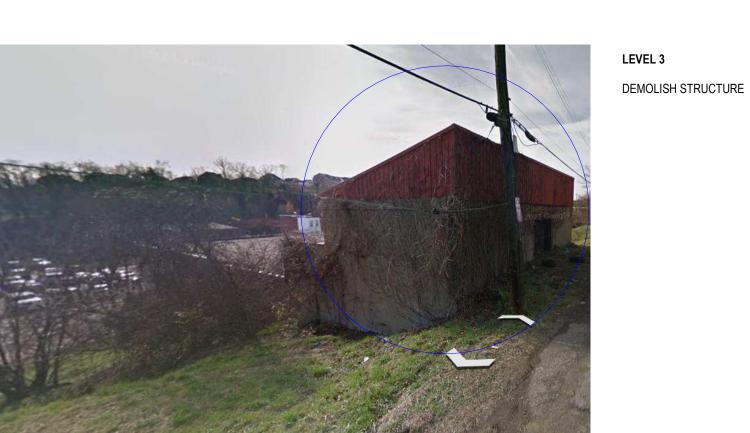

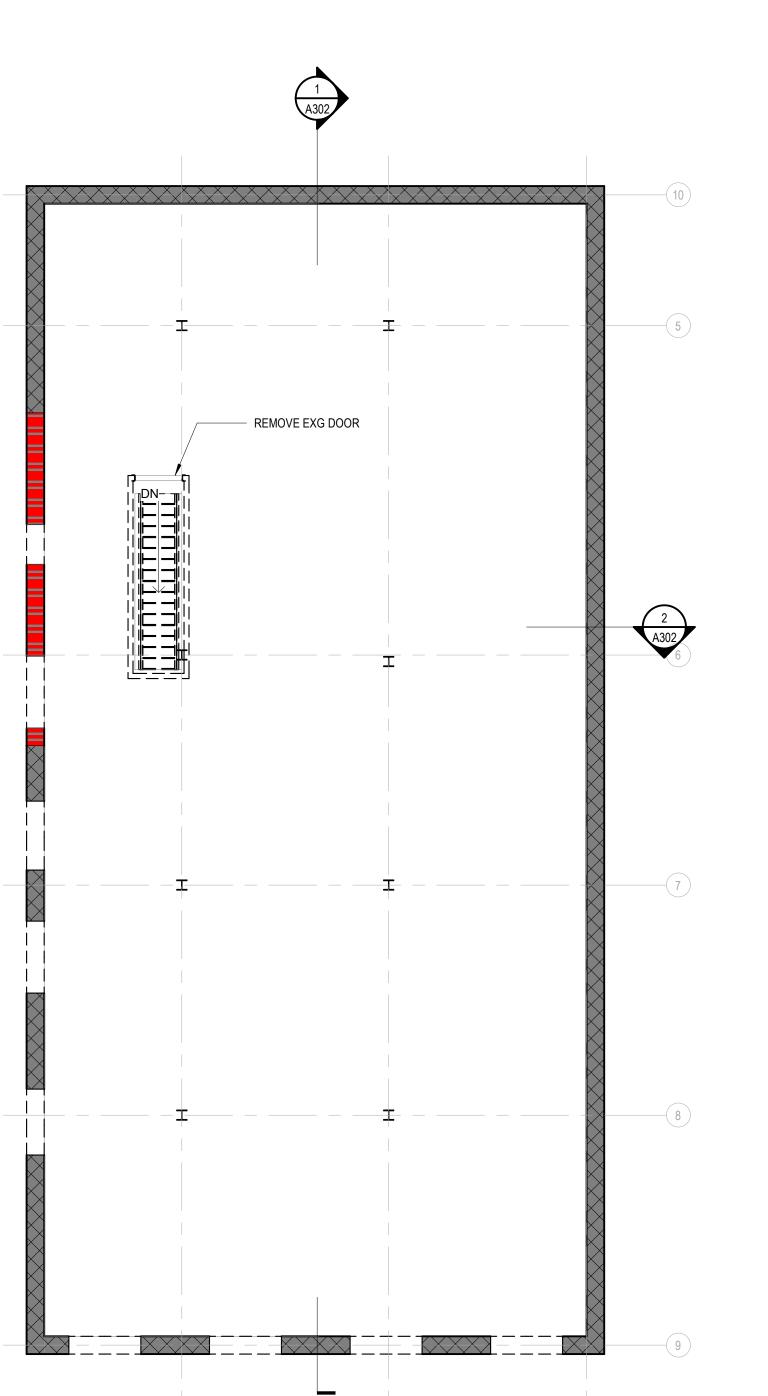

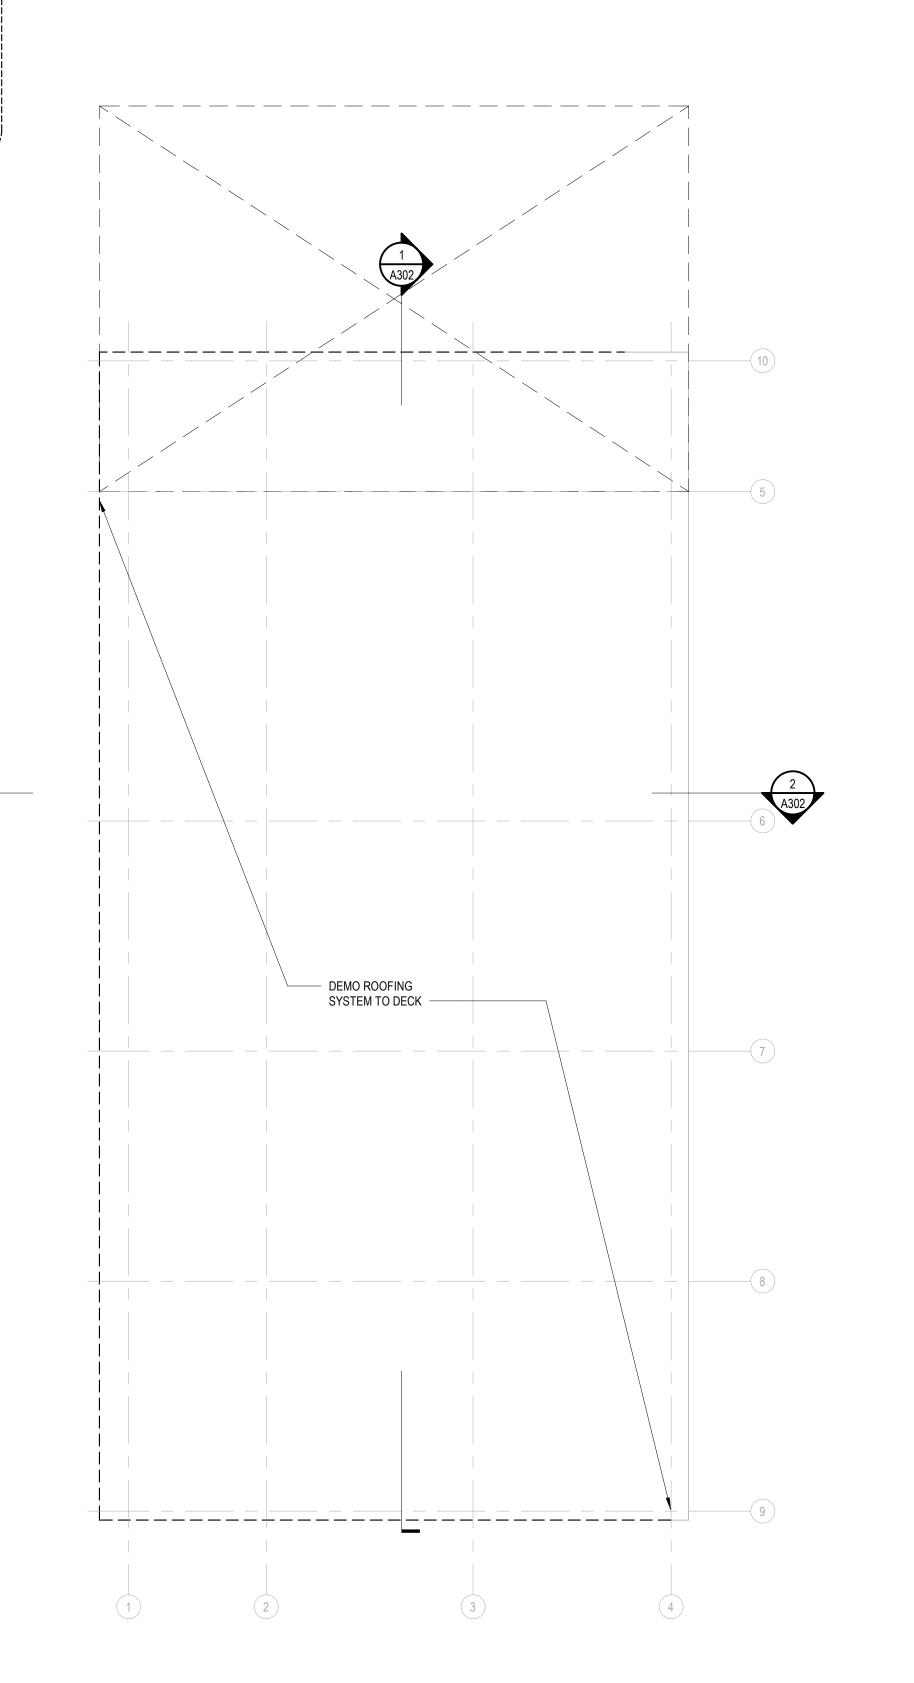

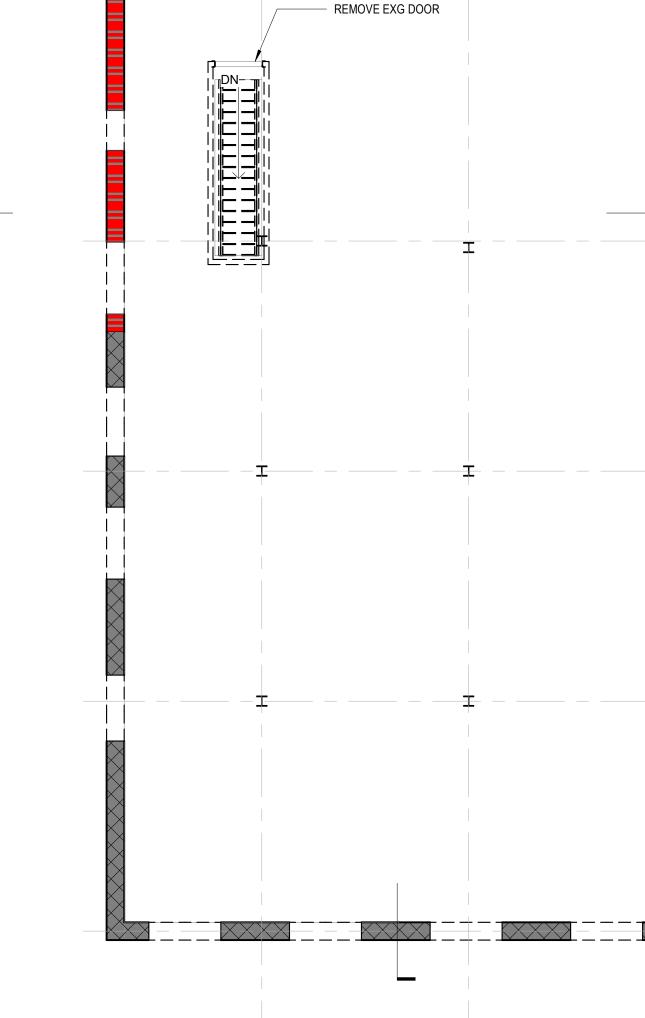

1 LEVEL 1 DEMOLITION PLAN

SCALE: 1/8" = 1'-0"

27'-9 1/4"

A302

2 LEVEL 2 DEMOLITION PLAN
SCALE: 1/8" = 1'-0"

3 LEVEL 3 DEMOLITION PLAN

SCALE: 1/8" = 1'-0"



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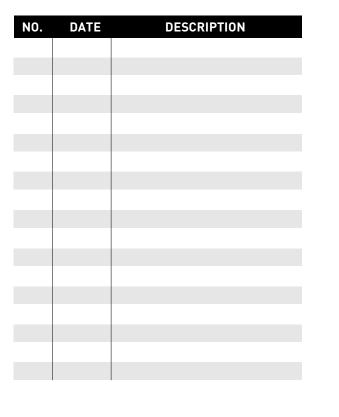
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DRAWING ISSUE

SCHEMATIC DESIGN



DRAWING TITLE

FLOOR PLANS

9

RELIMINARY CONSTRUCTION

JOB NUMBER

14754



12/20/2022 1:37:50 PM Auto

1 2 A302 3 LEVEL 2

FLOOR PLAN

A101 SCALE: 1/8" = 1'-0"

ARTIST STUDIO 922 SF

STUDIO 451 SF

 $\begin{pmatrix} 4 \\ A101 \end{pmatrix}$

GBBN.COM

 EXCEPT AS INDICATED OTHERWISE, CEILINGS ON THIS PLAN ARE 9'-0" ABOVE THE FINISHED REFER TO CEILING DETAILS FOR TYPICAL SOFFIT AND BULKHEAD HEIGHTS RELATIVE TO

ADJACENT CEILING PLANES UNLESS INDICATED OTHERWISE ON THIS PLAN.

B. CEILING AND DEVICE LAYOUT LOCATE ACOUSTIC CEILING PANELS CENTERED WITHIN THE ROOM UNLESS INDICATED

 CEILING-MOUNTED DEVICES ARE SHOWN FOR THE PURPOSE OF OVERALL LAYOUT WITHIN THE CEILINGS.

 NOT ALL DEVICES ARE SHOWN ON THIS PLAN. REFER TO MECHANICAL, ELECTRICAL. TECHNOLOGY, SECURITY EQUIPMENT AND OTHER APPLICABLE DRAWINGS FOR OTHER CEILING MOUNTED DEVICES NOT SHOWN ON THIS PLAN. FOR DEVICES MOUNTED IN ACOUSTIC CEILINGS, LOCATE CENTERED IN THE ACOUSTIC CEILING PANELS UNLESS INDICATED OTHERWISE.

 FOR DEVICES MOUNTED IN HARD CEILINGS SURFACES (GYPSUM BOARD, PLASTER, EXPOSED STRUCTURE) AND NOT DIMENSIONED, LOCATE DEVICES ALONG A CENTERLINE AXIS AND SPACED EQUALLY.

C. CEILING DETAILS TYPICAL CEILING DETAILS MAY NOT BE MARKED ON THIS PLAN. REFER TO CEILING DETAILS FOR TYPICAL SOFFIT AND BULKHEAD CONDITIONS.

 REFER TO CEILING DETAILS FOR CEILING MATERIALS AND HEIGHT TRANSITIONS UNLESS INDICATED OTHERWISE. D. ACCESS PANELS EACH TRADE SHALL PROVIDE ACCESS PANELS IN HARD CEILINGS TO ACCES ABOVE-CEILING

 WHERE ACCESS PANELS ARE LOCATED ON THE CEILING PLAN, COORDINATE LOCATION OF ABOVE-CEILING DEVICES TO CONFORM TO THE LOCATION SHOWN. WHERE ACCESS PANELS ARE NOT LOCATED ON THE CEILING PLAN, PROVIDE LAYOUT DIAGRAM TO THE ARCHITECT FOR APPROVAL PRIOR TO INSTALLATION.


E. FIRE SUPPRESSION SYSTEMS REFER TO FIRE PROTECTION DOCUMENTS FOR FIRE SUPPRESSION SYSTEM REQUIREMENTS AND SCOPE OF WORK AS APPLICABLE.

 WHERE SPRINKLER HEADS <u>ARE NOT</u> SHOWN ON THIS PLAN: • IN ACOUSTIC CEILING PANELS, LOCATE CENTERED IN ACOUSTIC CEILING PANELS.

 IN HARD SURFACE CEILINGS, LOCATE SPRINKLER HEADS - TO THE GREATEST EXTENT POSSIBLE - ALONG A SHARED CENTERLINE AXIS. WHERE SPRINKLER HEADS ARE SHOWN ON THIS PLAN: SPRINKLER HEADS ARE LOCATED FOR AESTHETIC LAYOUT.

INSTALLED LOCATIONS AND QUANTITIES SHALL MEET THE REQUIREMENTS OF THE FIRE SUPPRESSION SYSTEM SCOPE OF WORK AND APPLICABLE CODES. WHERE ADJUSTMENTS ARE REQUIRED, FINAL LOCATIONS ARE SUBJECT TO THE APPROVAL OF THE ARCHITECT.

REFLECTED CEILING PLAN LEGEND

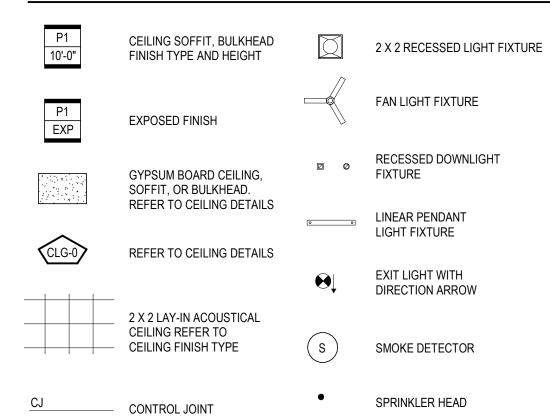

HEX (C) REFLECTED CEILING PLAN NOTES KEYNOTE DESCRIPTION

Service of the servic

LEVEL 1 REFLECTED CEILING PLAN

SCALE: 1/8" = 1'-0"


A302 5

LEVEL 2 REFLECTED CEILING PLAN
SCALE: 1/8" = 1'-0"

3 LEVEL 3 REFLECTED CEILING PLAN
SCALE: 1/8" = 1'-0"

DRAWING ISSUE

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DRAWING TITLE

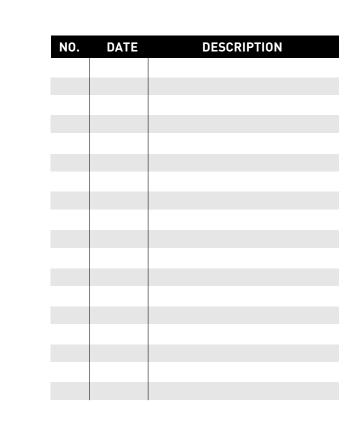

14754



REFLECTED CEILING **PLANS**

JOB NUMBER

12.19.22



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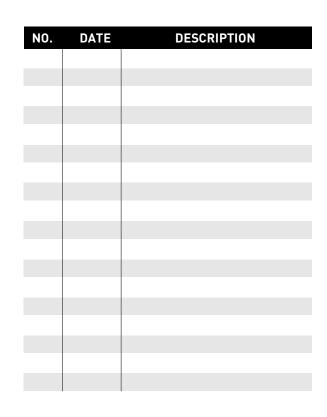
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SCHEMATIC DESIGN



DRAWING TITLE

BUILDING EXTERIOR 3-D VIEWS


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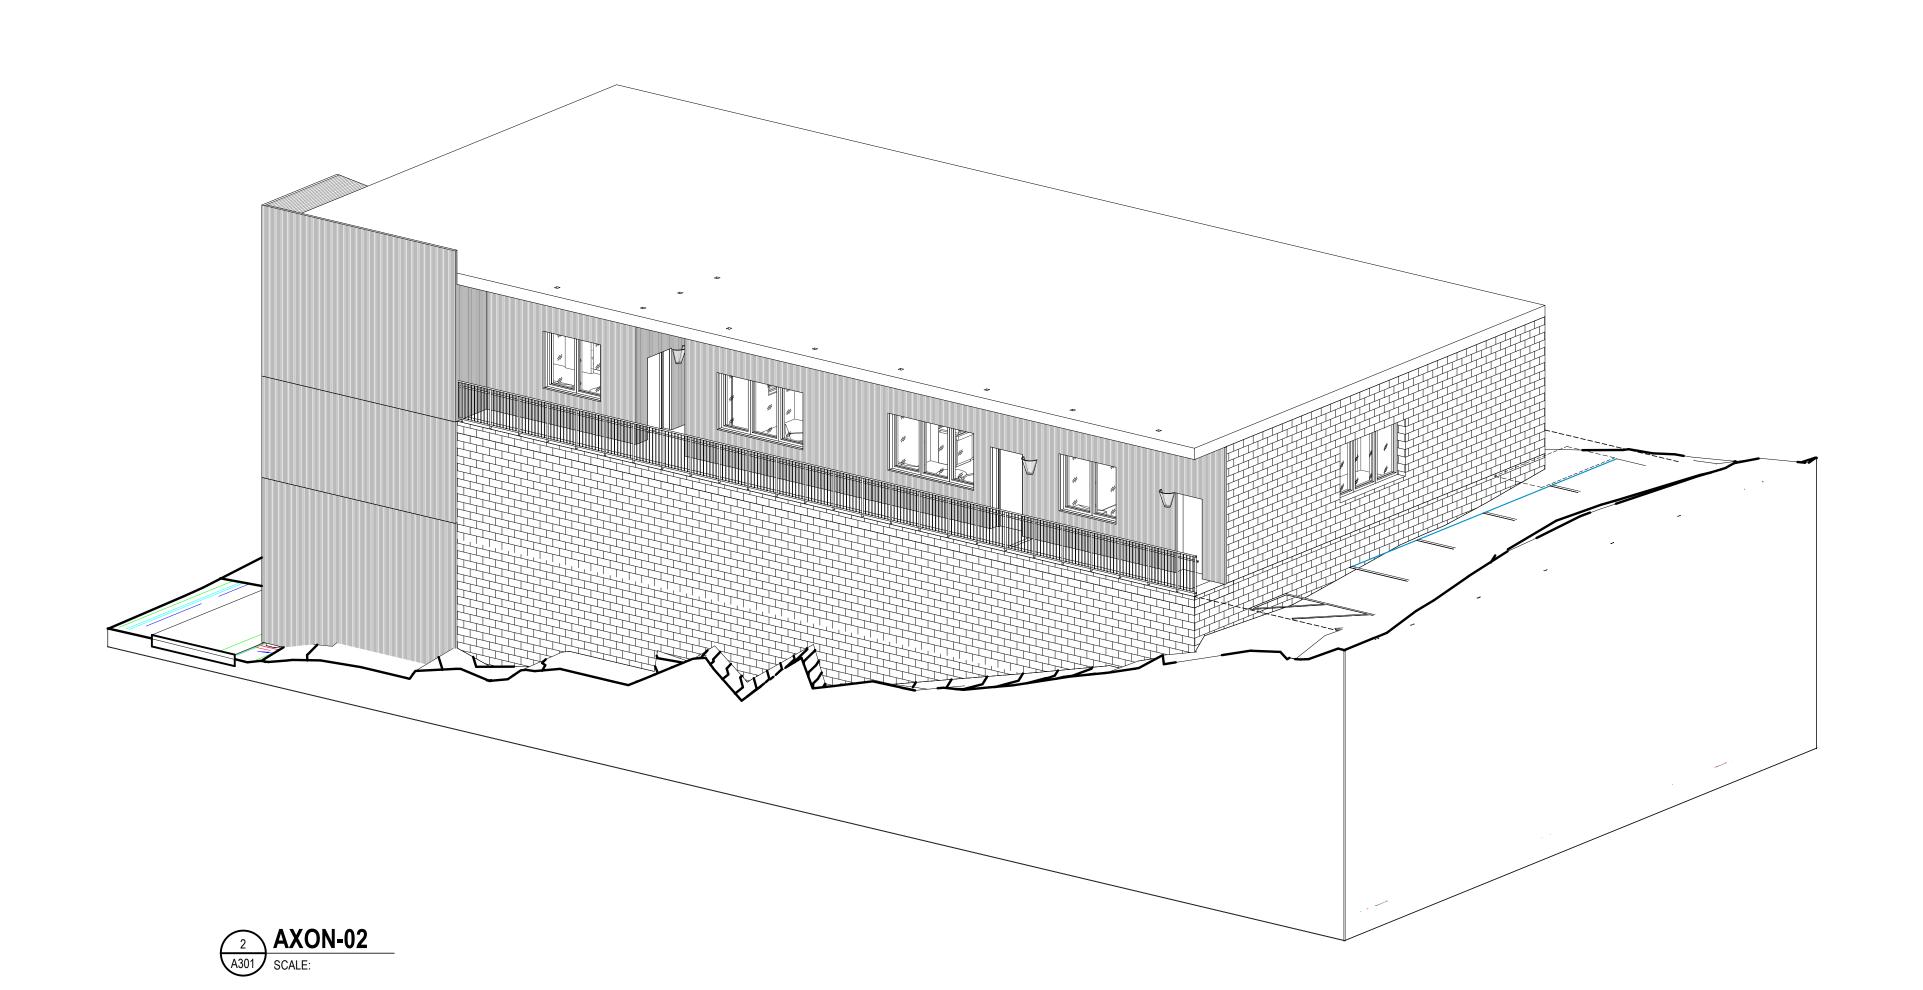


JOB NUMBER

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DRAWING ISSUE

DRAWING TITLE

JOB NUMBER

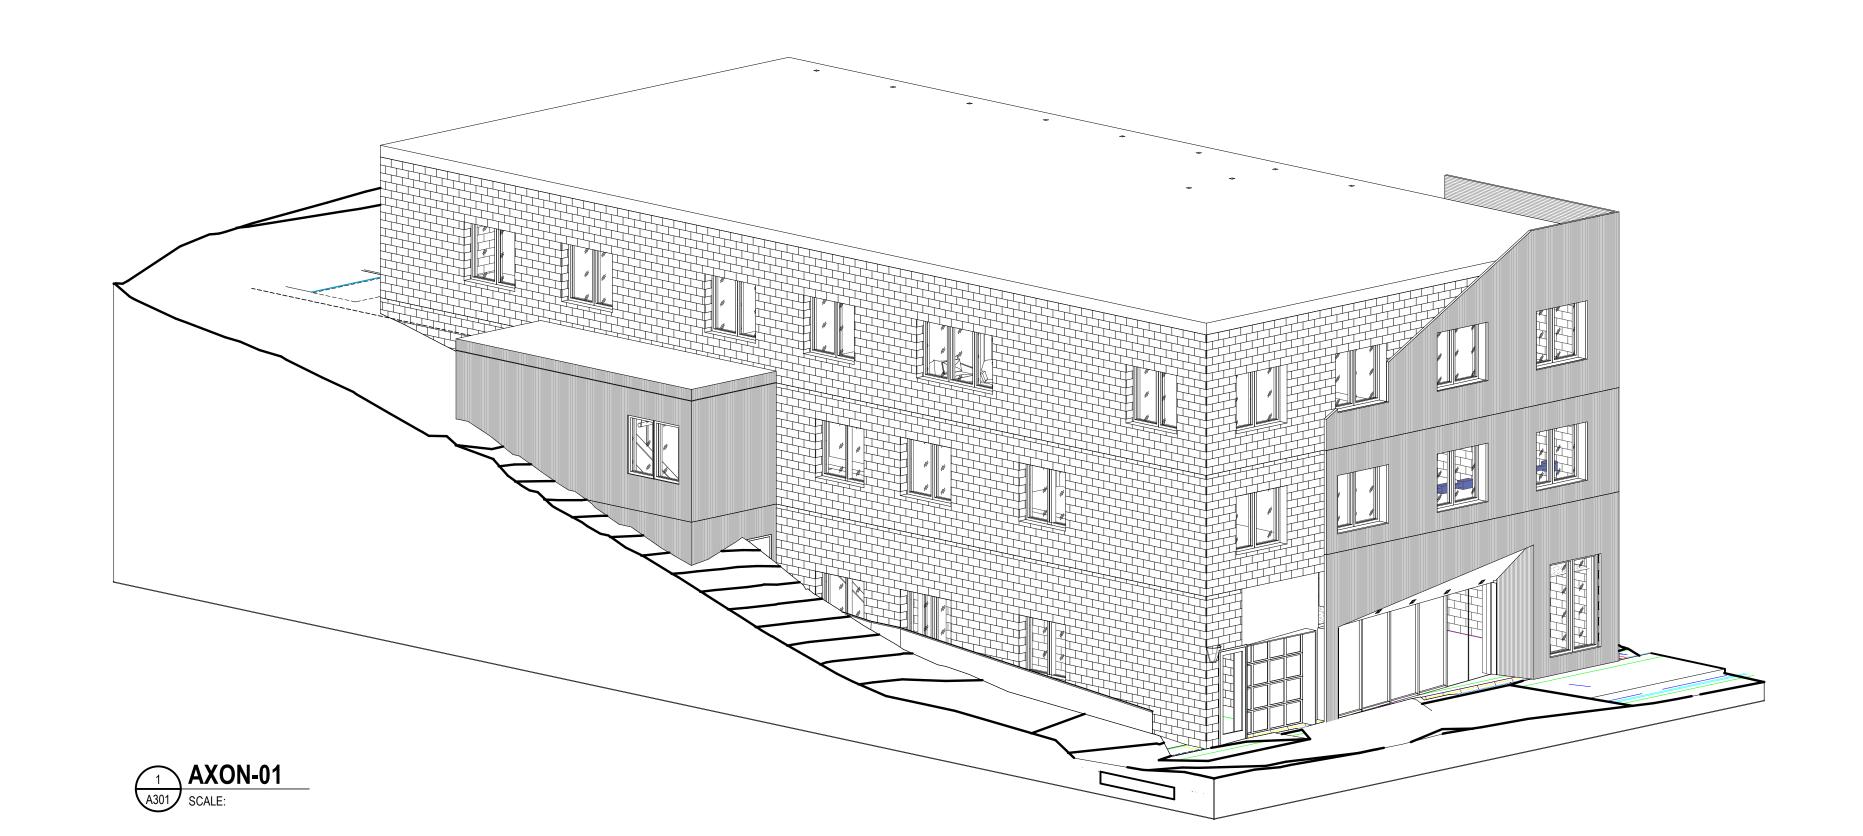BUILDING

ELEVATIONS-SECTIONS

SCHEMATIC DESIGN

GYPSUM BOARD -ASSEMBLY R-VALUE: 51 **E2**

GENERAL NOTES - EXTERIOR WALL TYPES:

Exerior Details

AIR/VAPPOR BARRIER

EXISTING WALL

MINERAL WOOL INSULATION WITH INTERNAL GIRTS (R17.2)

TUCKPOINT EXG MASONRY —

OPTION 1

EXISTING WALL -

OPTION 2

MINERAL WOOL INSULATION (R-13.7)

FIRE RETARDANT-TREATED WOOD STUD

EXTERIOR CLADDING RAINSCREEN
SYSTEM. CORRUGATED METAL PANEL
IMETCO COR-PAN OR EQUAL

ASSEMBLY R-VALUE: 25

MODIFICATION LEVEL 1 — MODIFICATION LEVEL 2

ROOF 1019' - 4"

<u>LEVEL 3</u> 1007' - 4"


AIR/VAPPOR BARRIER — MINERAL WOOL INSULATION WITH INTERNAL GIRTS (R17.2) EXTERIOR CLADDING RAINSCREEN
SYSTEM. FLAT METAL PANEL IMETCO
COR-PAN OR EQUAL

ASSEMBLY R-VALUE: 51

E2

12.19.22

14754

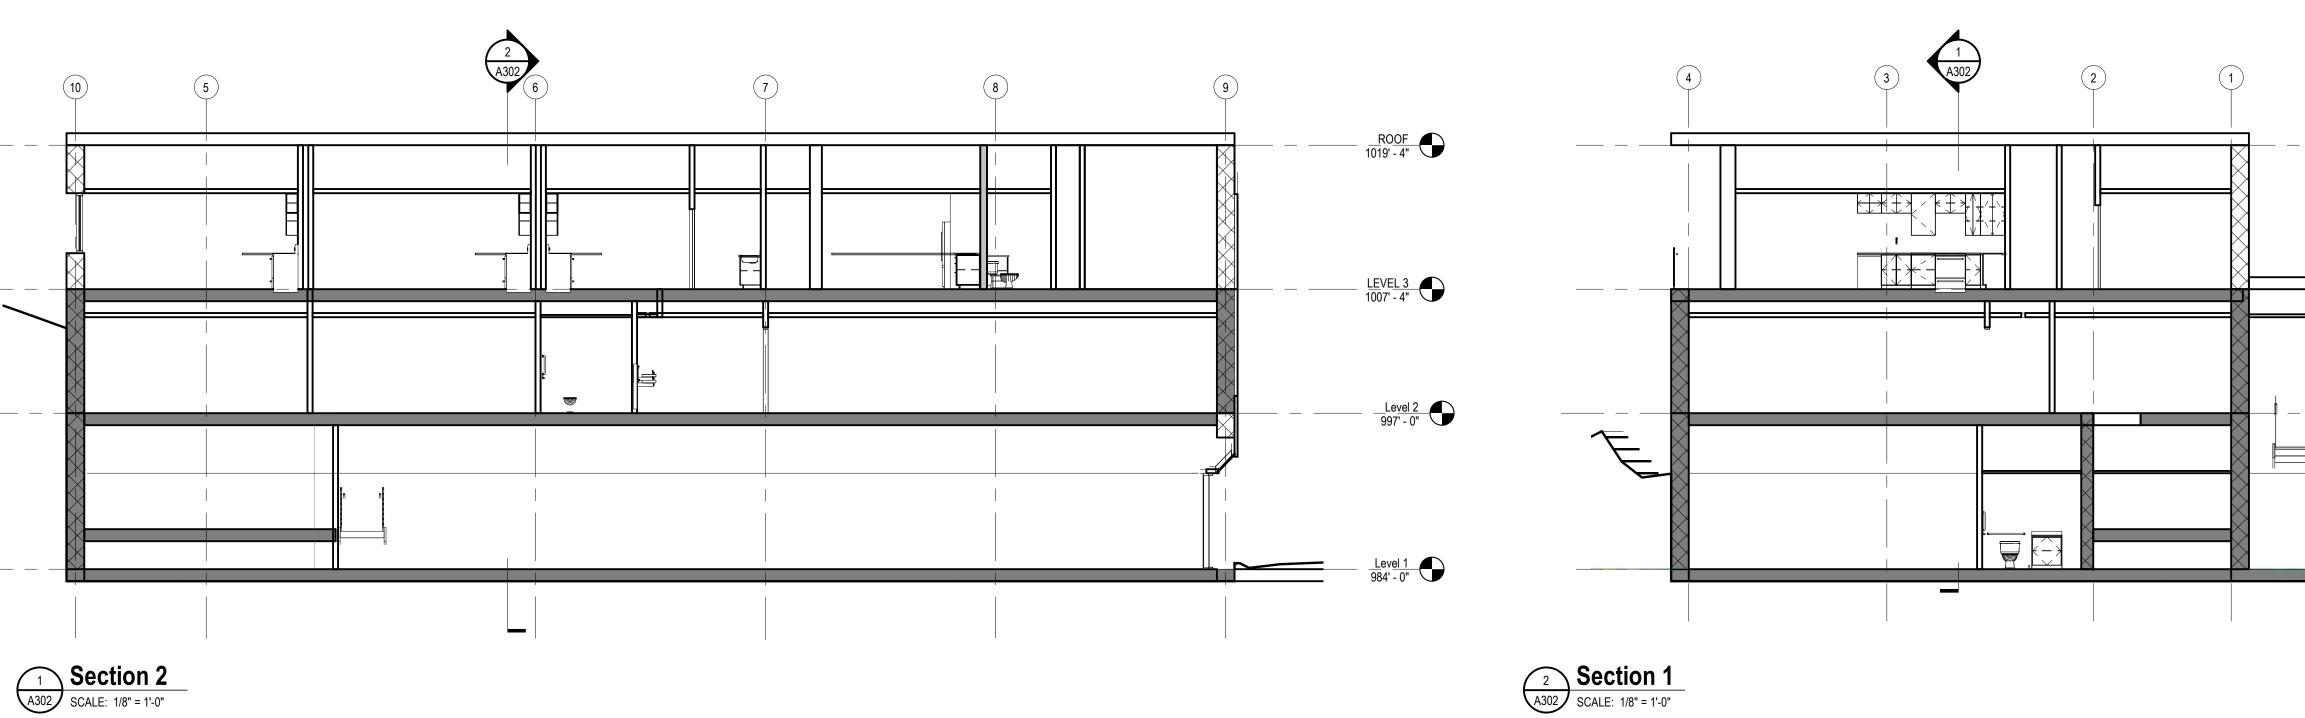


2 Section 1
SCALE: 1/8" = 1'-0"

ROOF 1019' - 4"

LEVEL 3 1007' - 4"


Level 1 984' - 0"

ROOF 1019' - 4" LEVEL 3 1007' - 4"

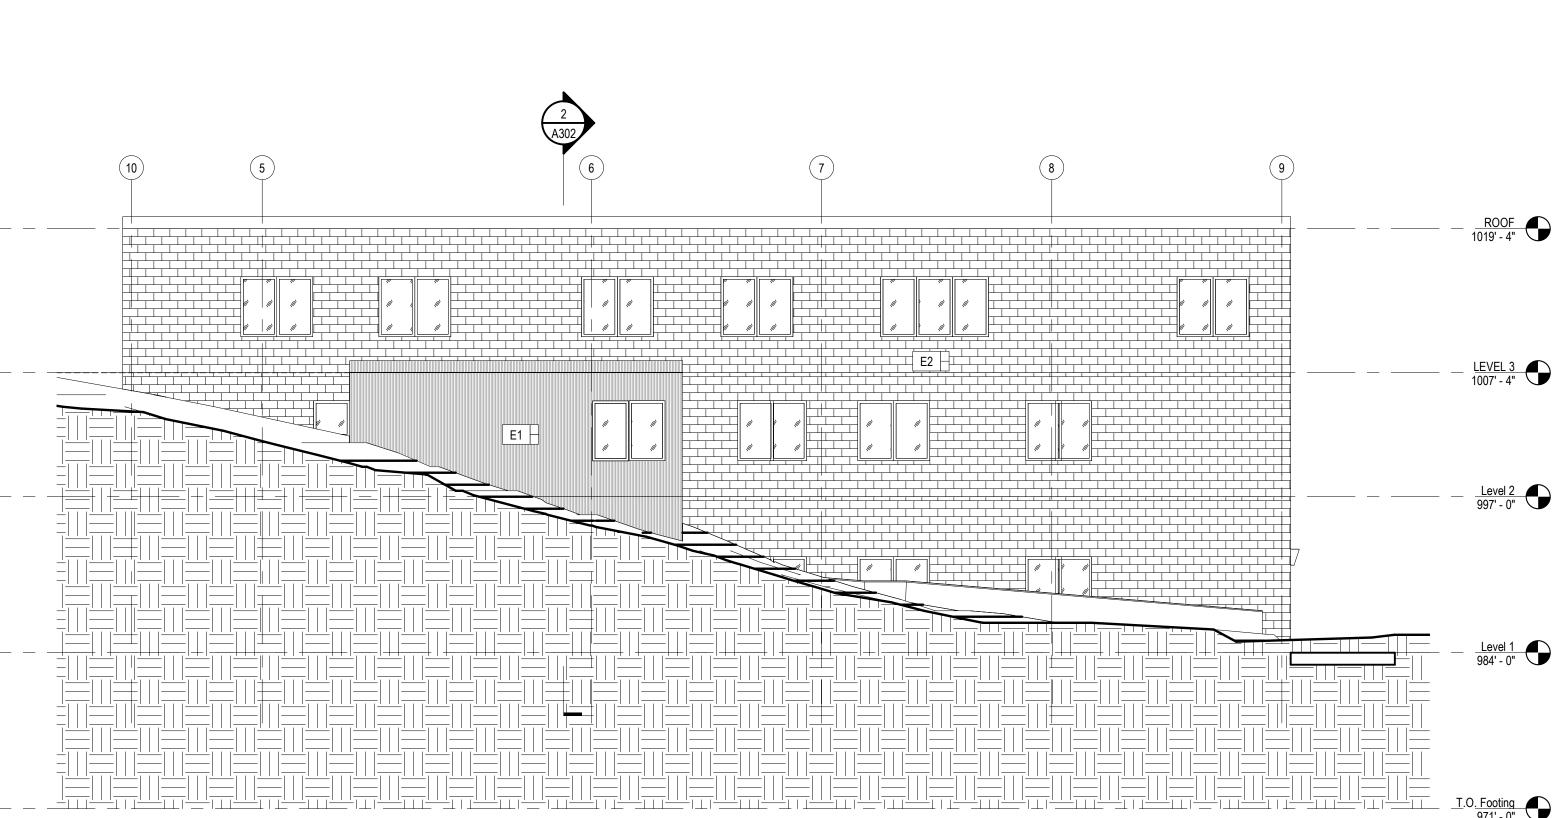


E1 🖯

5 West
SCALE: 1/8" = 1'-0"

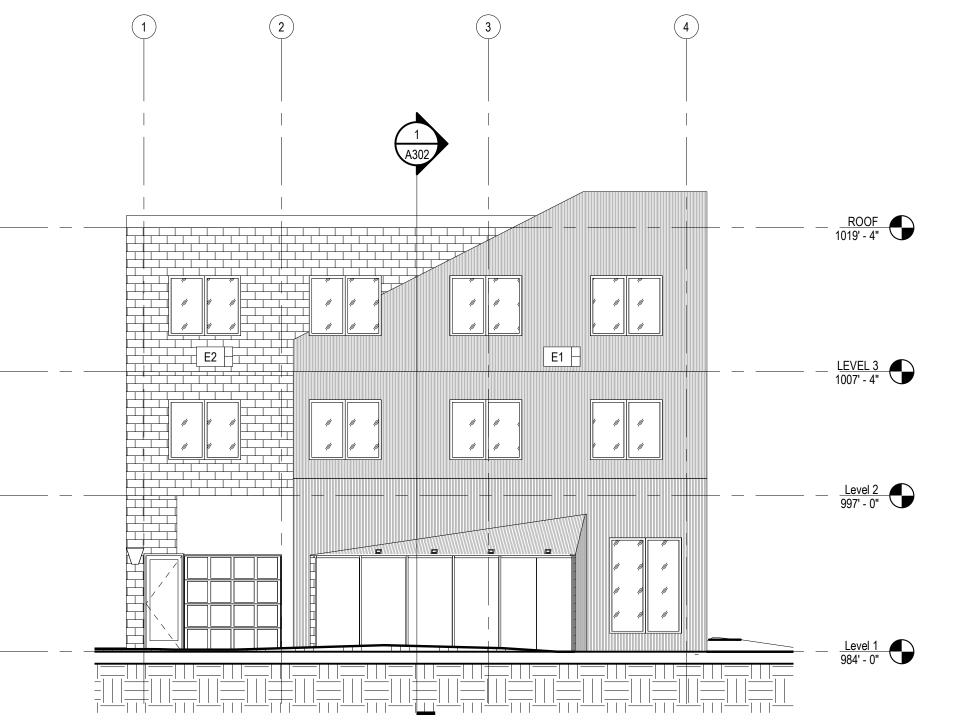

4 North
A302 SCALE: 1/8" = 1'-0"

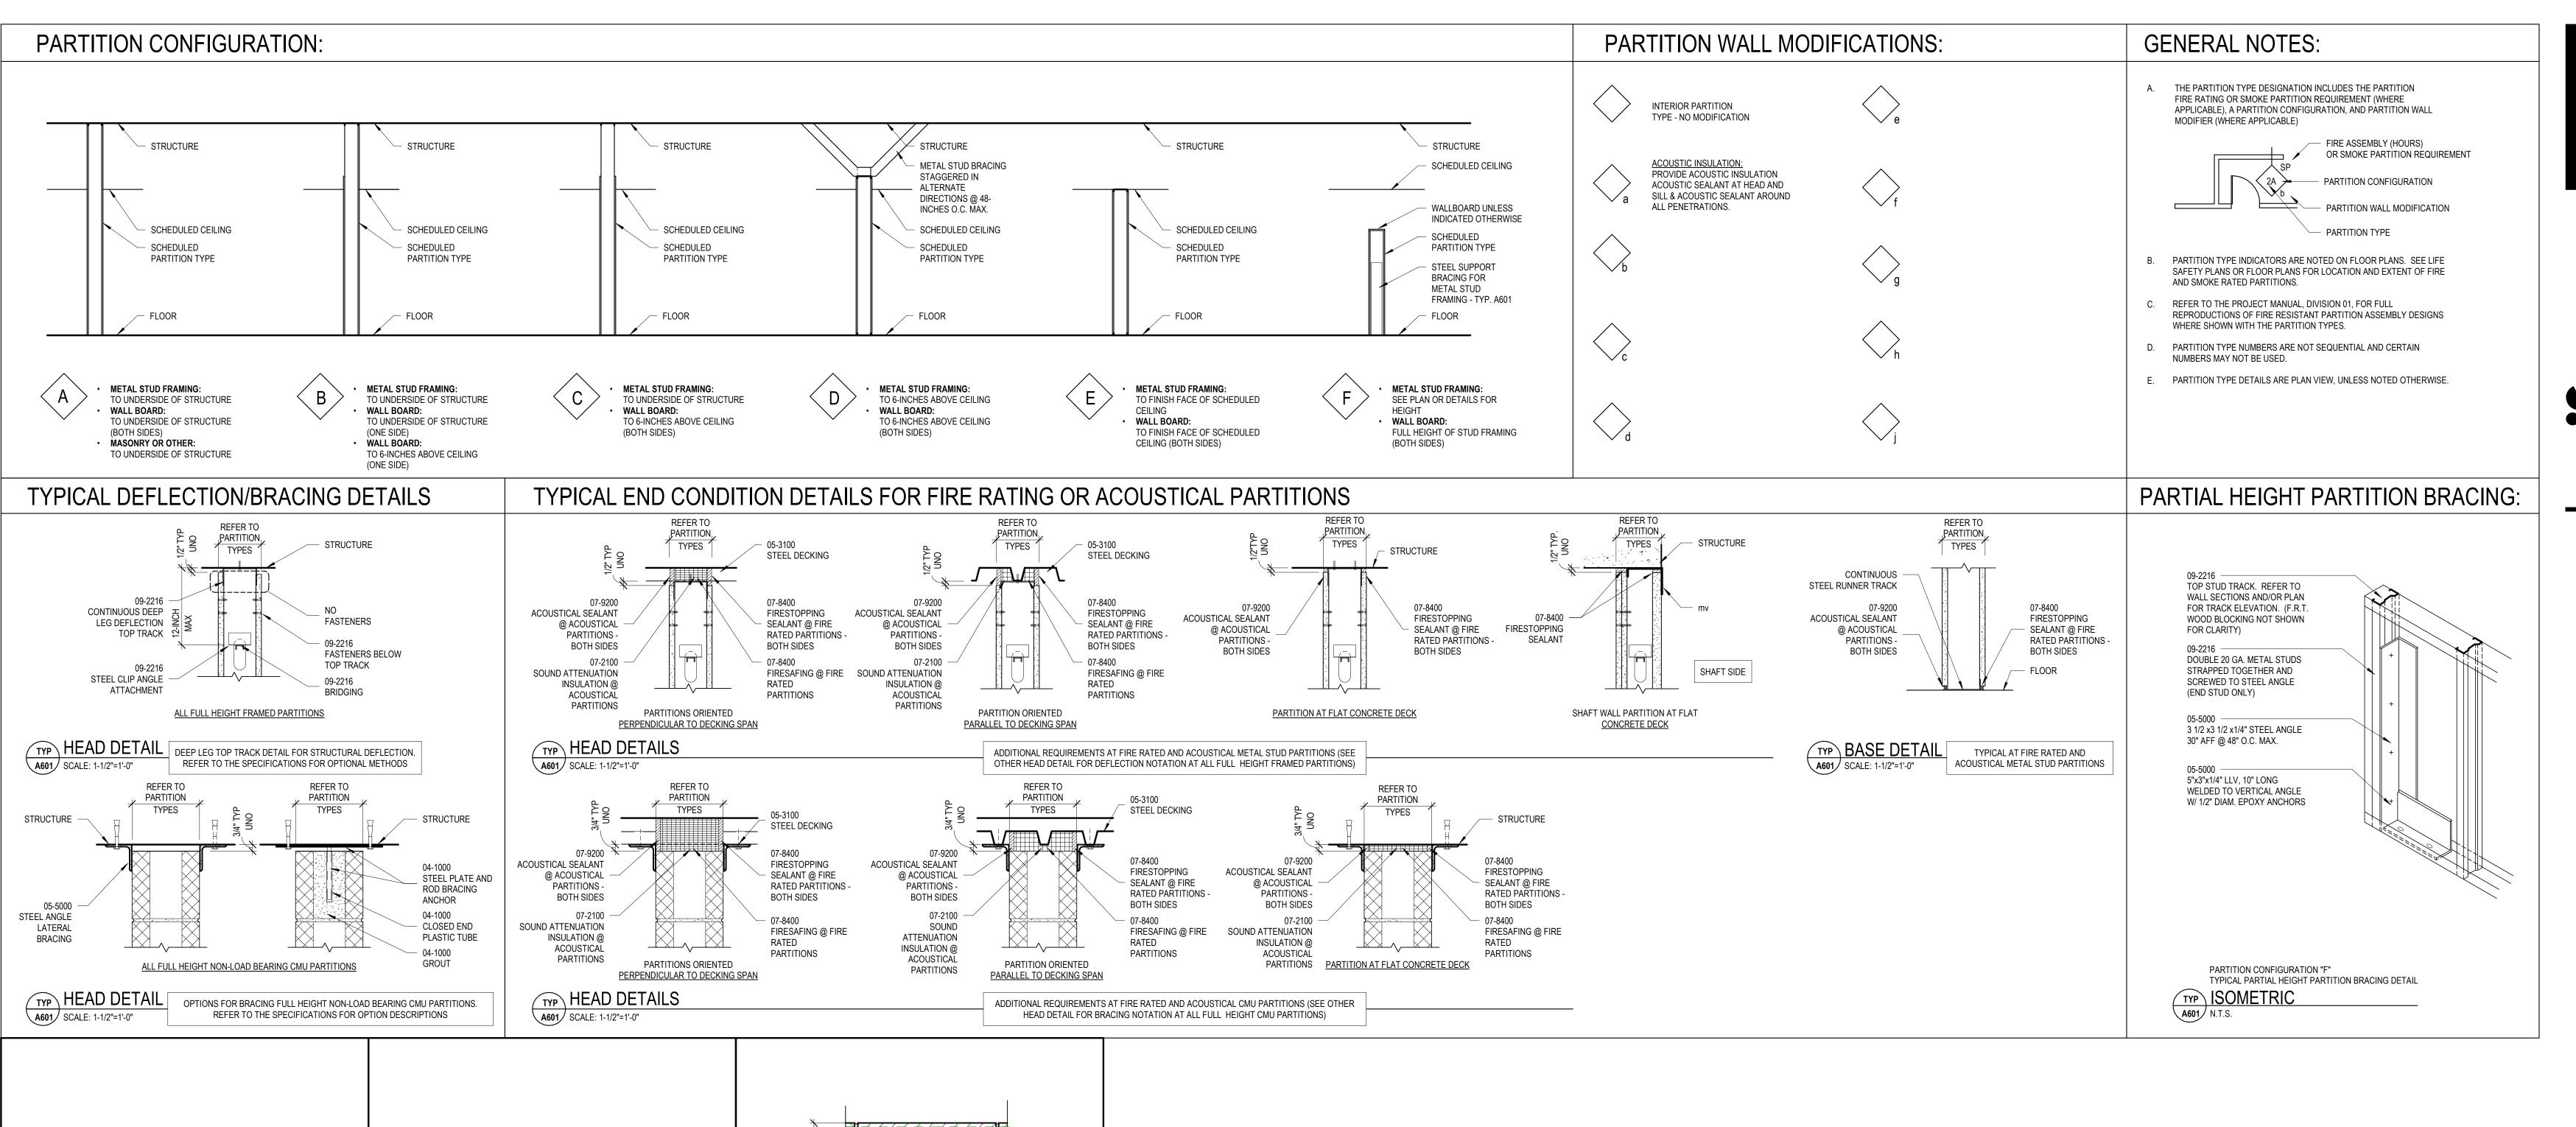

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NO. DATE DESCRIPTION

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PARTITION TYPES AND DETAILS

JOB NUMBER

14754

3 5/8-INCH STEEL

STUD FRAMING

5/8-INCH GYPSUM

(IF INDICATED BY

TAG ON PLANS)

- 09-2900

BOARD

REFER TO THE PROJECT

DETAILED TESTING

MANUAL, DIVISION 01, FOR

ASSEMBLY INFORMATION

FIRE RESISTANCE: 1HR UL U419

(IF INDICATED BY

TAG ON PLANS)

— 09-2216

09-2900

BOARD

2 1/2-INCH STEEL

STUD FRAMING

5/8-INCH GYPSUM

FIRE RESISTANCE: 1HR=U906; TYPE D-2

(IF INDICATED BY 2HR=U906; TYPE D-2 3HR=U907; TYPE C-3

(IF INDICATED BY 2HR=U906; TYPE D-2

4HR=U907; TYPE B-4

CONCRETE MASONRY UNITS

NOMINAL 8-INCH THICK

MANUAL, DIVISION 01, FOR DETAIL ED TESTING

ASSEMBLY INFORMATION